Standard Details for Adoptable Pump Station Design

April 2021



Standard Details for Adoptable Pump Station Design

The drawings included in this document are typical details for an adoptable pump station designed in accordance with the Design and Construction Guidance, Local Practices and Technical Standards contained within Code for Adoption (2020).

Please refer to our Local Practice for Pump Stations (Design Criteria for the Adoption of Small Submersible Foul and Surface Water Pumping Stations) which can be found on our website https://www.yorkshirewater.com/developers/sewerage/

These drawings are to be used as a guide for our design criteria. All drawings submitted for assessment must be site specific and detailed as such accordingly.

This document contains the following Standard Details for Adoptable Pump Station Design:


- Pumping Station Plan View
- Pumping Station Elevation View
- Pumping Station Site View (Single Pump)
- Pumping Station Kiosk and Plinth Details
- Pumping Station Plan View of Kiosk and Plinth
- Pumping Station Hazardous Zoning Detail
- Pumping Station Site View (Dual Pump)
- Pumping Station Boundary Treatment Options

For further information please contact us:

Telephone 0345 120 84 82

Email <u>technical.sewerage@yorkshirewater.co.uk</u>

Web https://www.yorkshirewater.com/developers/sewerage/

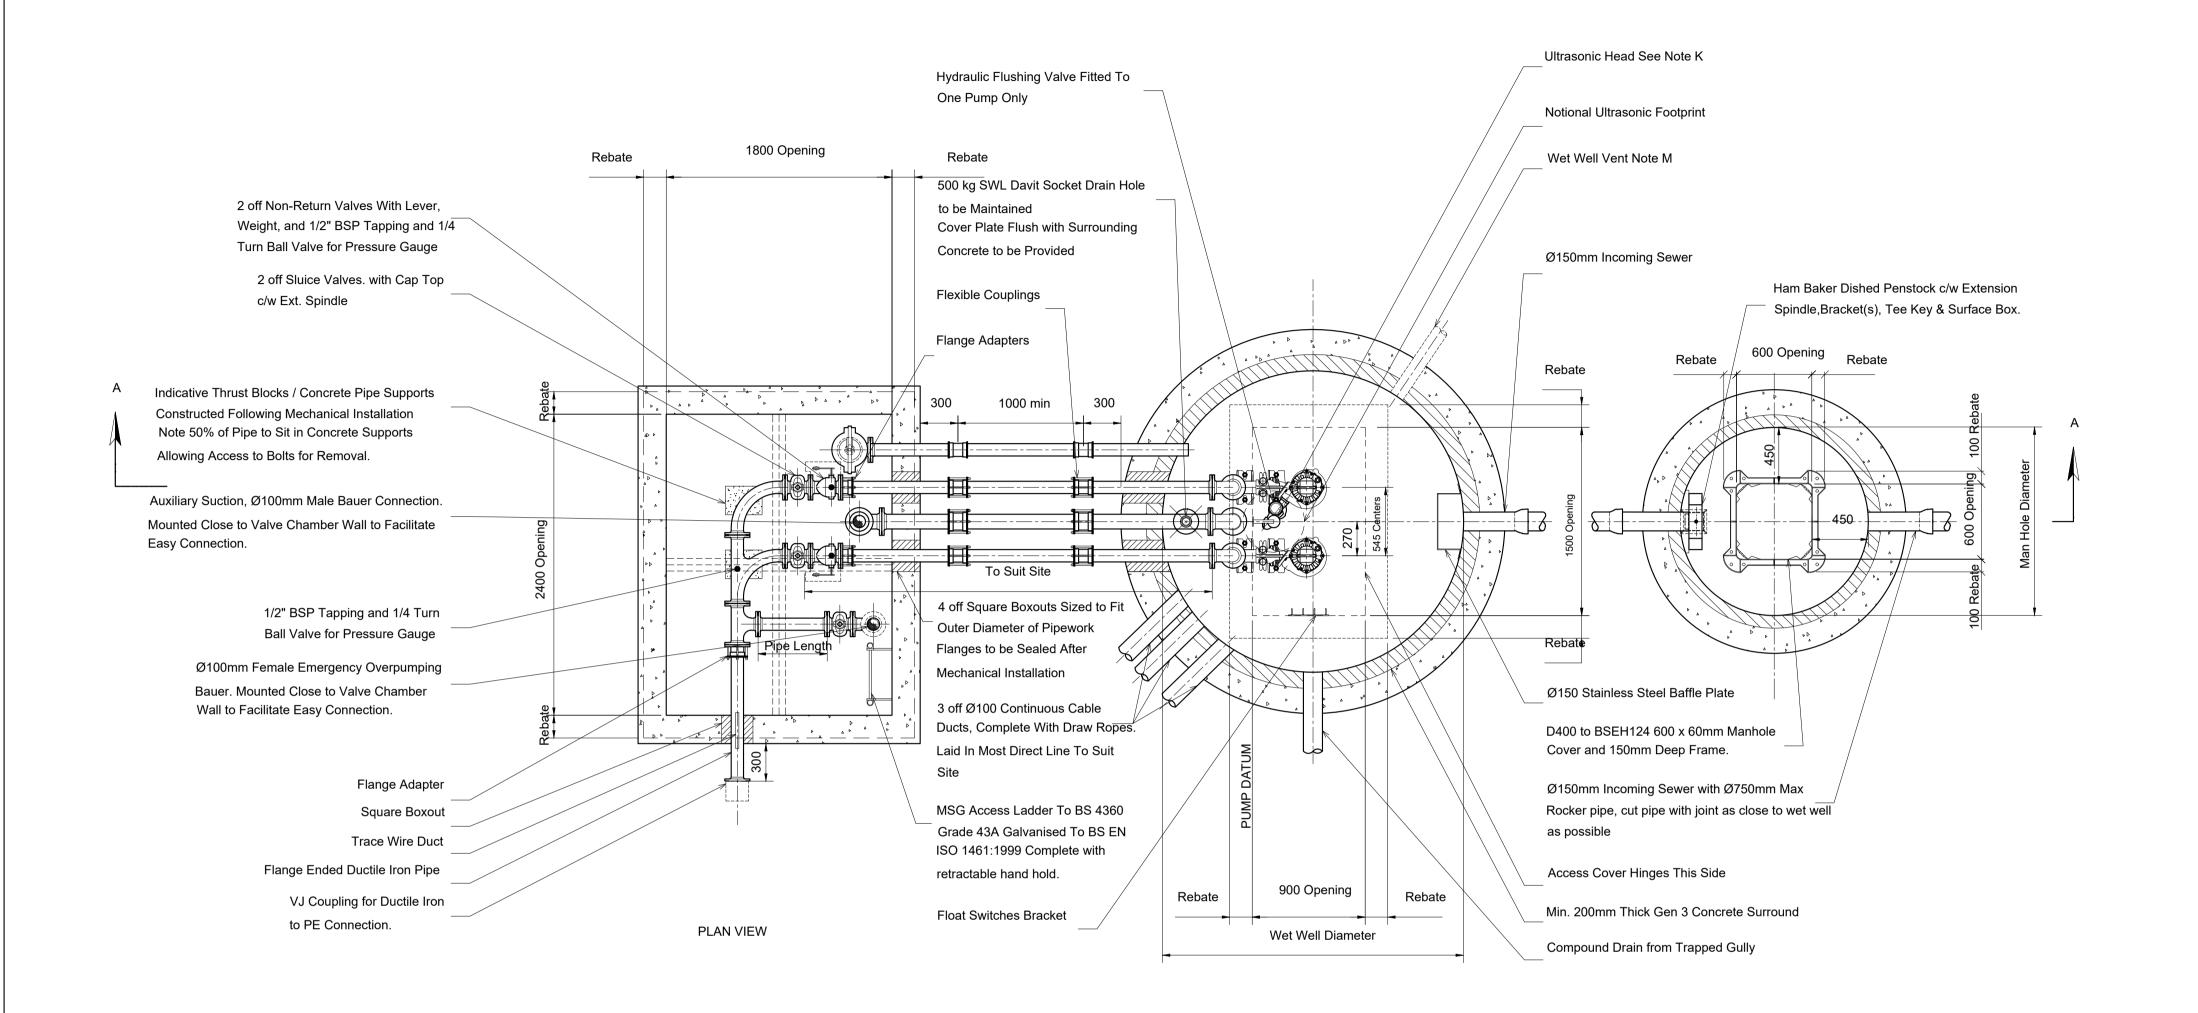

NOTES

A DO NOT SCALE.

B ALL DIMENSIONS IN MILLIMETRES, ALL INVERTS IN METRES AOD, UNLESS OTHERWISE STATED.

C ALL CIVIL WORK BY OTHERS INCLUDING MAKING GOOD AROUND PIPES AFTER INSTALLATION, BENCHING, FIXING ACCESS COVERS AND LAYING CABLE DUCTS.

D REINFORCING BARS TO BE 75mm MIN. BELOW SURFACE. STRUCTURAL DETAIL ILLUSTRATIVE ONLY, MAY BE WORKED TO FOR DIMENSIONS

BENCHING TO BE FORMED AS LAID DOWN IN 'SEWERS FOR ADOPTION' 7th EDITION AND TO LOCAL/ADOPTING AUTHORITY SPECIFICATIONS.

F BENCHING TO BE FORMED AFTER PUMP INSTALLATION.

G ALL DUCTS 100 I.D. MIN. COMPLETE WITH DRAW ROPES AND AVOIDING ACUTE CHANGES OF DIRECTION. SERVICE DUCTS TO SUPPLIERS SPECIFICATIONS

H DIRECTION OF DUCTS SHOWN DIAGRAMMATICALLY - ALL DUCTS TO BE LAID ON MOST DIRECT LINE TO SUIT SERVICE BEING

J SITE PLAN ILLUSTRATIVE IF NO SPECIFIC DETAILS PREVIOUSLY PROVIDED.

K LEVEL CONTROLS SHOWN NOTIONALLY, TO BE POSITIONED AWAY FROM OBSTRUCTIONS, LEVELS READILY ADJUSTABLE AFTER INSTALLATION.

L CIVIL WORKS ARE INDICATIVE AND SHOULD NOT BE USED FOR CONSTRUCTION.

M GALVANIZED MILD STEEL VENT STACK WITH A

MINIMUM DIAMETER OF 100mm FITTED WITH A MILD STEEL MESH AT THE TOP; WHERE LOCATED IN A FENCED COMPOUND THE VENT STACK SHOULD TERMINATE AT THE SAME HEIGHT AS THE BOUNDARY FENCING OR IN RESIDENTIAL AREAS THE STACK CAN BE A MINIMUM OF 100mm OR UP TO THE HEIGHT OF THE FENCE WITH A SWAN NECK.

N COVERS TO BE CAPABLE OF BEING LIFTED WITH AN EFFORT NOT EXCEEDING 25Kg

P ALL FITTINGS TO BE STAINLESS STEEL

REVISION DATE INITIALS DESCRIPTION AMENDMENTS ABOVE LEGEND



New Supplies, Service Centre - Water, P.O. Box 52, Bradford, BD3 7YD

SCHEME TITLE: PUMP STATION (PLAN) **GENERAL ARRANGEMENT**

SCHEME DETAILS: -----

ICE REF:

DEVELOPER: DESIGNER: WENDY MULLANEY X1DEV No: ORDER No: N.T.S SCALE: ORDER No: GRID REF: ----FIRE REF:

DRAWING No: YWS-DS-SD-WW-001

1 COVER TO RE-INFORCEMENT TO BE 40mm TO BOTH

2 SPACERS TO BE 1200mm CENTRE TO CENTRE.

3 CONCRETE TO BE 30 N/mm AT 28 DAYS.

4 GROUND BEARING PRESSURE TAKEN AS 50 KN/M.

5 NO DAY WORK JOINTS PERMITTED IN SLABS. 6 ALL SOFT SPOTS TO BE REMOVED AND REPLACED

BY SUITABLE MATERIAL. 7 PROVIDE 50MM BLINDING CONCRETE.

8 ALL WORKMANSHIP AND MATERIALS MUST CONFORM TO CURRENT CODES OF PRACTICE AND BUILDING REGULATIONS.

9 MINIMUM BAR LAP LENGTH 800mm.

10 WET WELL AND VALVE CHAMBER COVERS TO BE AS SUPPLIED BY PUMP SUPPLIER.

11 TO BE READ IN CONJUNCTION WITH THE CIVILS DETAILS.

12 ANY OVER BREAK BETWEEN THE LAST ACCESS CHAMBER AND THE WET WELL AND BETWEEN THE WET WELL AND THE VALVE CHAMBER TO BE FILLED WITH LEAN MIX CONCRETE.

13 WET WELL TO BE CLEAN AND DRY BEFORE INSTALLATION OF PUMPS COMMENCES.

14 DEWATERING TO BE PROVIDED IF NECESSARY AS WORKS PROCEED.

15 RISING MAIN TO BE (SPECIFICATION AND LENGTH TO BE CONFIRMED) LONG. MARKED WITH NON DEGRADABLE MARKER TAPE ABOVE RISING MAIN CONTAINING A TRACE WIRE TERMINATING WITH 1M OF WIRE COILED INSIDE THE VALVE CHAMBER.

COLOUR OF RISING MAIN TO BE BLACK/GREY

16 CUT OUT AND CUT IN LEVELS TO BE ESTABLISHED ON SITE BY PUMP SUPPLIER.

17 THE BRACKET FOR HOLDING THE DAVIT EQUIPMENT SHOULD BE KEPT IN THE KIOSK.

18 ALL REGULAR LEVEL SWITCHES USED WITHIN THE HAZARDOUS AREA MUST BE "EX RATED" 19 THRUST BLOCKS TO BE PROVIDED AT CHANGES IN

DIRECTION. 20 STATUTORY SERVICES TO PROVIDE ADEQUATE

SERVICES TO PUMP STATION AND KIOSK AND TO ALLOW

FOR ALL NECESSARY REQUIREMENTS. 21 KIOSK TO BE PROVIDED TO THE LATEST YW SFA6

M & E ADDENDUM. 22 DUCTS WITHIN WET WELL SHOULD NOT BE SEALED WITH FOAM, THEY SHOULD BE SEALED WITHIN THE KIOSK.

23 EXTERNAL LEVELS AROUND THE BOUNDARY COMPOUND TO BE AGREED IN A PRE-START MEETING WITH AN INSPECTOR, SO THAT THEY FLOW TOWARDS THE GULLY.

All Adoptable Sewer works & materials to be in accordance with the Sewers For Adoption 7th Edition, the relevant British, European & Yorkshire Water standards, requirements & Addendum to the Mechanical & Electrical Specification and Kite


IF BOXOUT HOLES TO BE CORE DRILLED. Civil's To Ensure All Core Drillings Are Parallel To Centre Line / Perpendicular To Valve Chamber

All Cut Pipe Joints As Close To Structures As

The Rocker Pipes To Be 1m Or Equal To One

Nominal Pipe Diameter Whichever Is The Larger

Possible Consistent With Making The Joint.

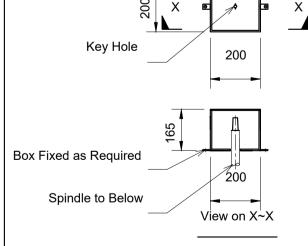

SPINDLE SURFACE BOX DETAIL (not to scale) Removable Lid with Retention Chain Plan View

PUMP INFORMATION

: ***k.W. Ex.P. ***A FLC

ULTRASONIC C/W HIGH

LEVEL ALARM AND

BACK UP FLOAT

SWITCHES

: DUCTILE IRON

: FLANGE ENDED

Ø***OD Ductile Ø*** PE

Ø***mm

Converter

PN16

***I/s

***m

TYPE OF LEVEL CONTROL HYDRORANGER

Ø***mm

PUMP TYPE

MOTOR RATING

HEAD GENERATED

PIPE / VALVE SIZE

FINAL CONNECTION

TERMINATION


FLANGE DATA

RM COUPLER

PIPE O.D.

IMPELLER

DUTY FLOW

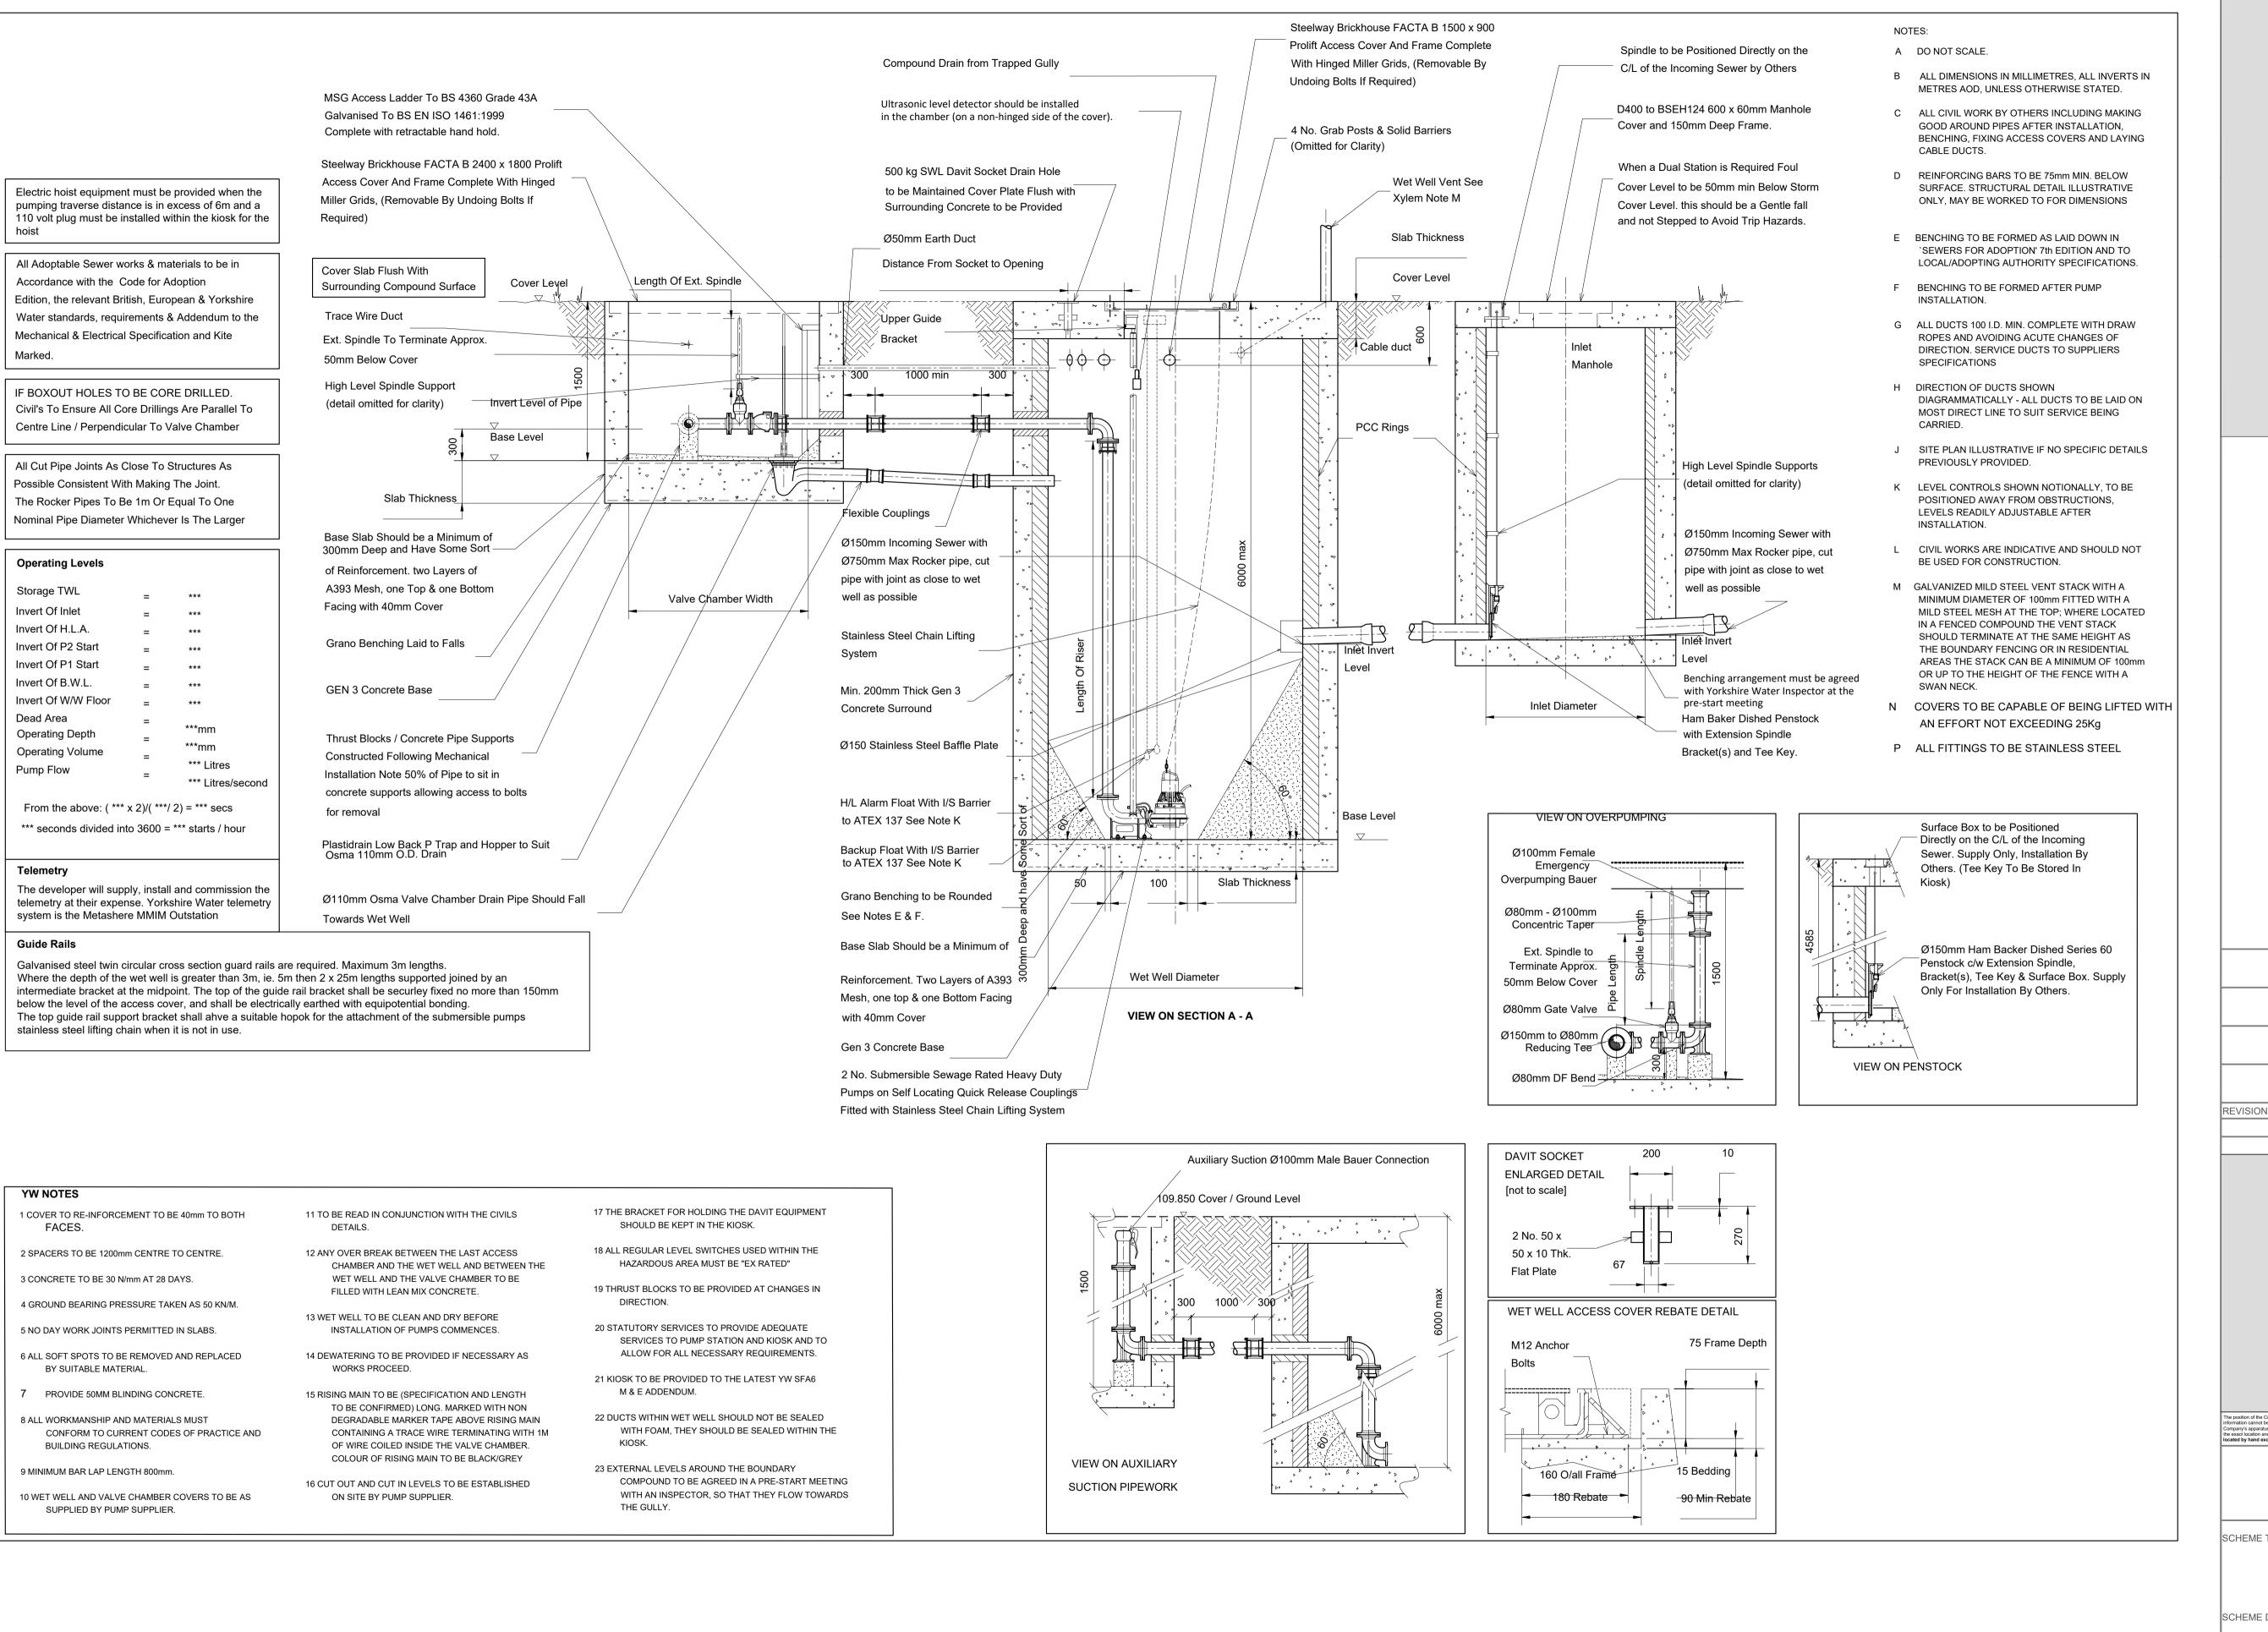

REVISION DATE INITIALS DESCRIPTION

LEGEND

AMENDMENTS ABOVE




SCHEME TITLE: PUMP STATION (ELEVATION) GENERAL ARRANGEMENT

SCHEME DETAILS: -----


DEVELOPER:

DESIGNER: WENDY MULLANEY X1DEV No: 14/01/2021 ORDER No: N.T.S SCALE: ORDER No: GRID REF: -----FIRE REF: ICE REF: DRAWING No: YWS-DS-SD-WW-002

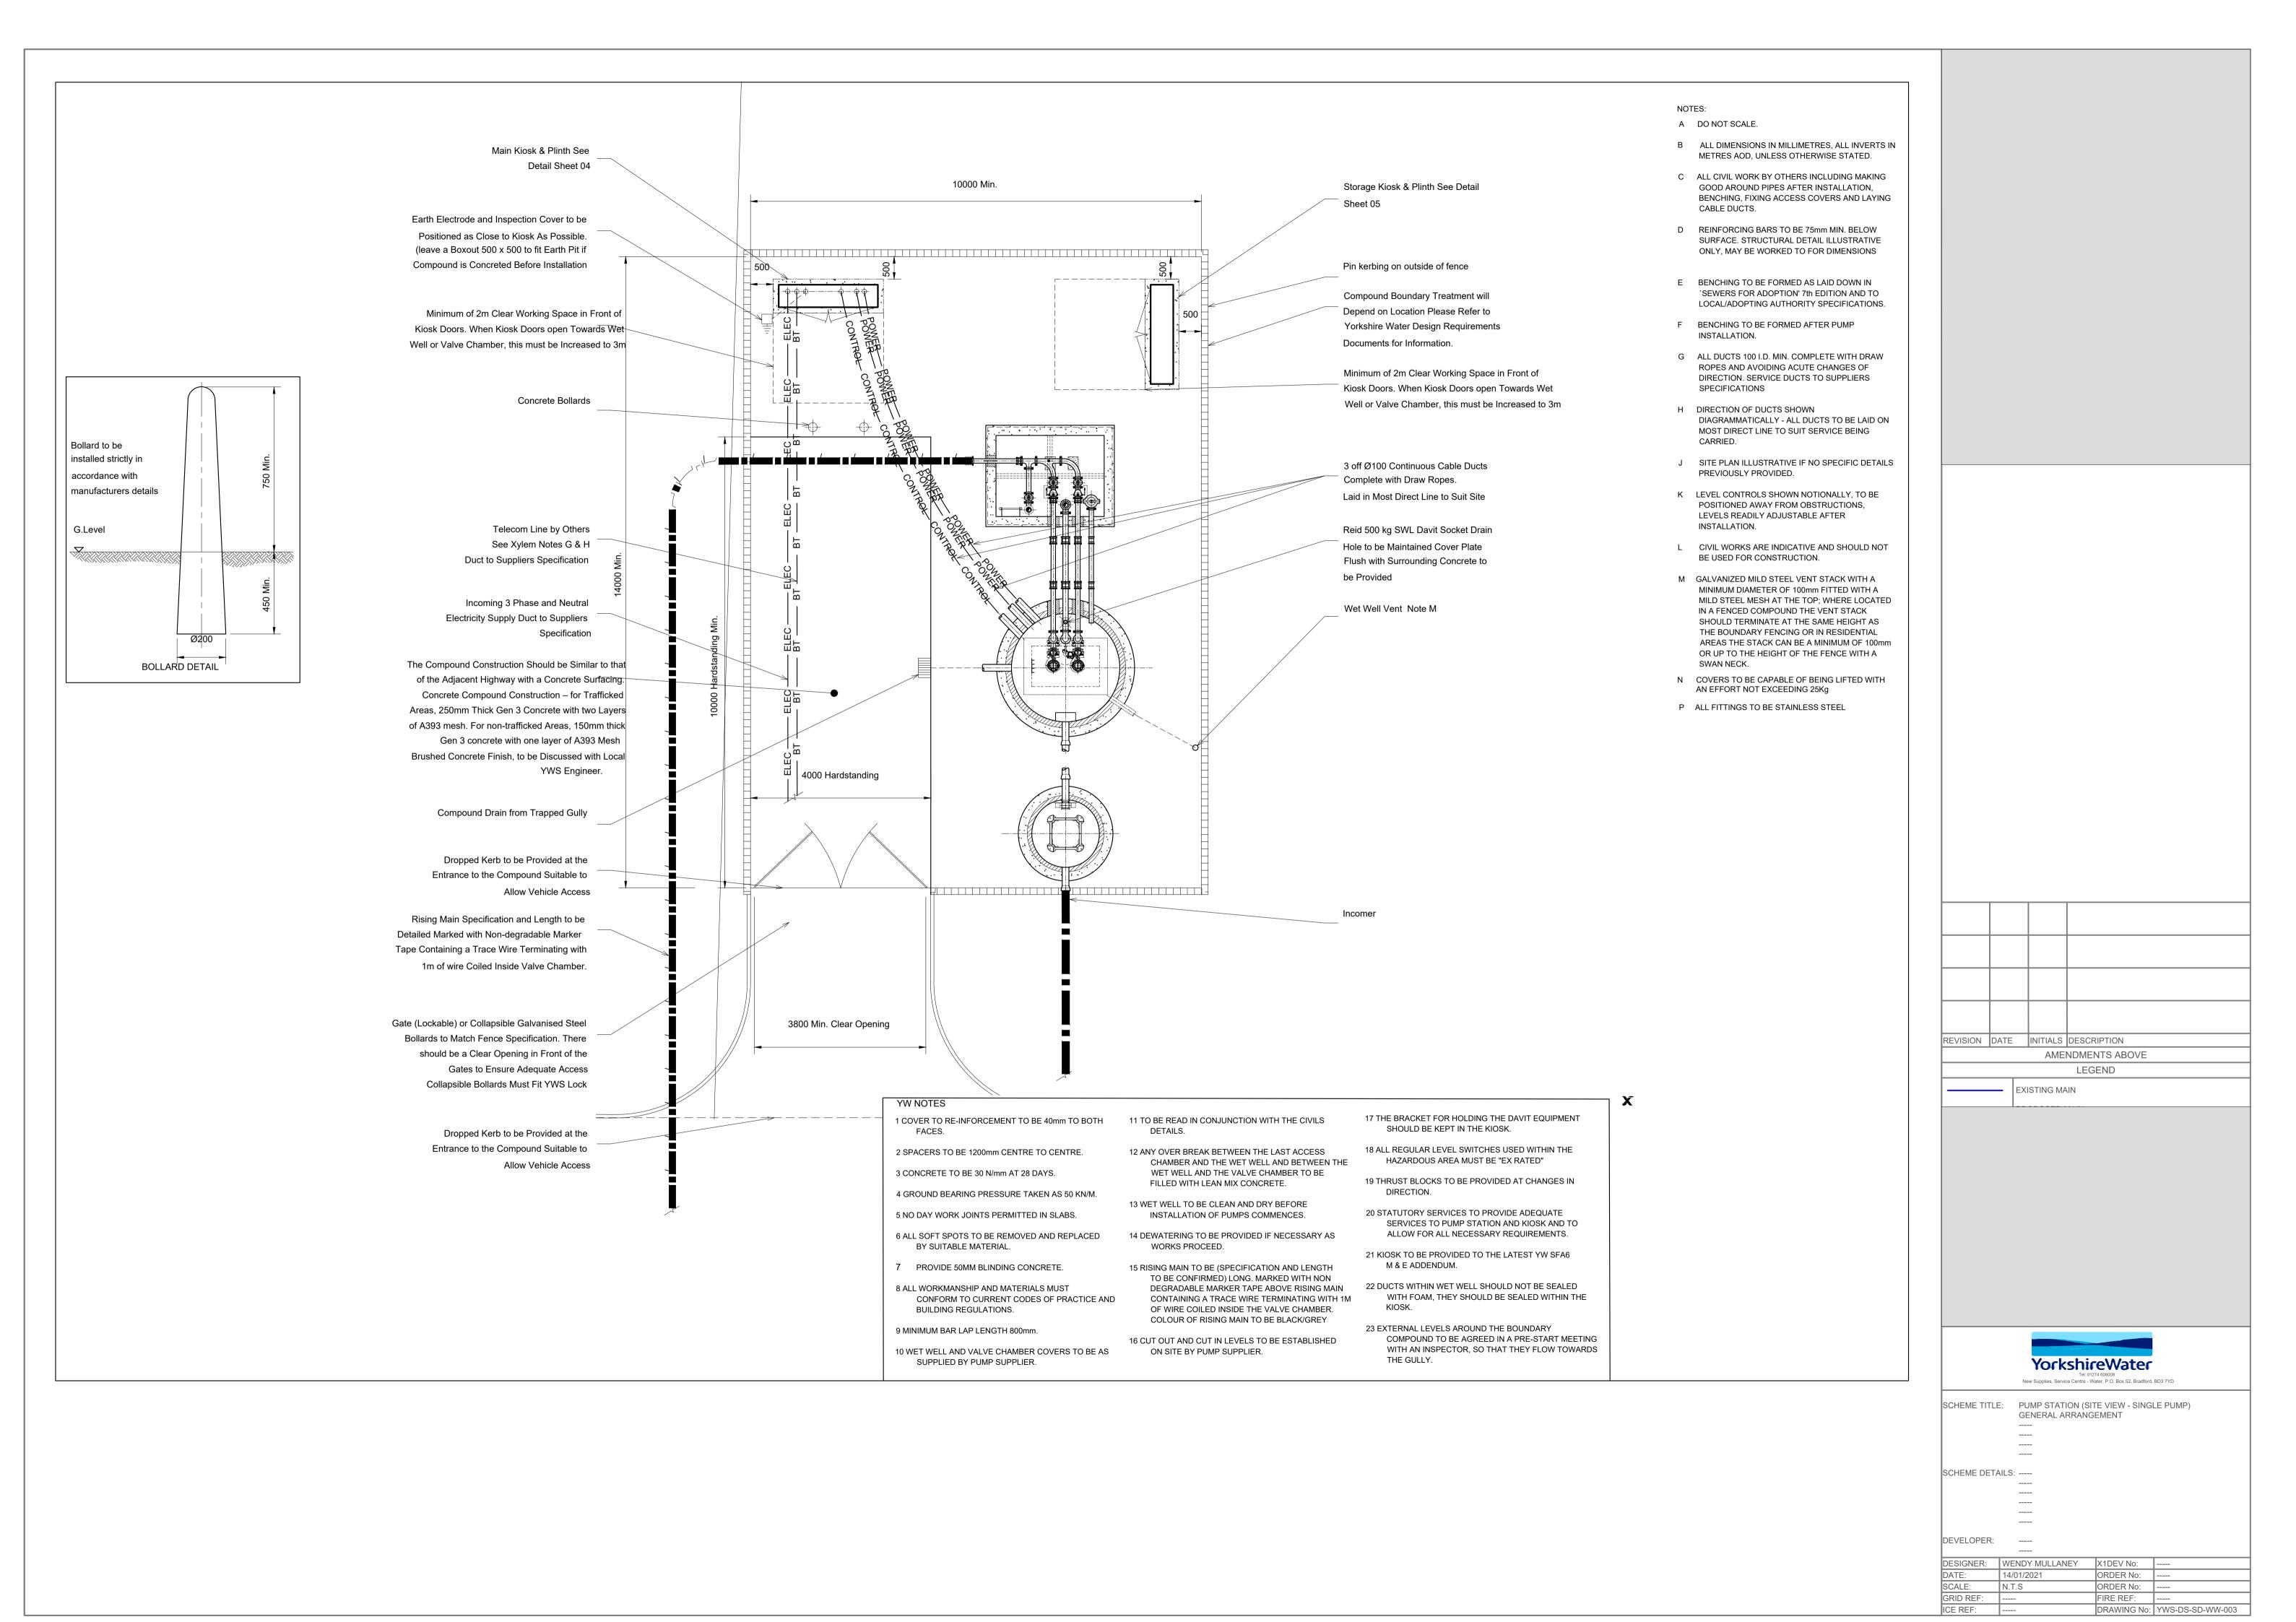

500 Kiosk 200mm Thick Gen 3 Concrete Base 20mm Chamfered Edges Clear Area in Front of Plinth to Slope away from Kiosk to Allow Surface Water to run off 150mm Type 1 Continuous Stone Sub Base. Cable Ducts VIEW ON SECTION B - B KIOSK DOORS FITTED WITH TRIANGULAR KEYED CAMLOCKS AT THE TOP AND BOTTOM OF EACH DOOR AND A SECURE HARDENED HASP AND STAPLE SIZED TO TAKE A YORKSHIRE WATER SIZED SERVICES PADLOCK. ALL CABLE DUCTS TO BE SEALED IN THE KIOSK AND CAPPED WITH A WITH A GAS TIGHT SEALING PUTTY 10ATEX 137 DIRECTIVE.

Kiosk 1350 high Kiosk Complies With Yorkshire Water's Code For Adoption

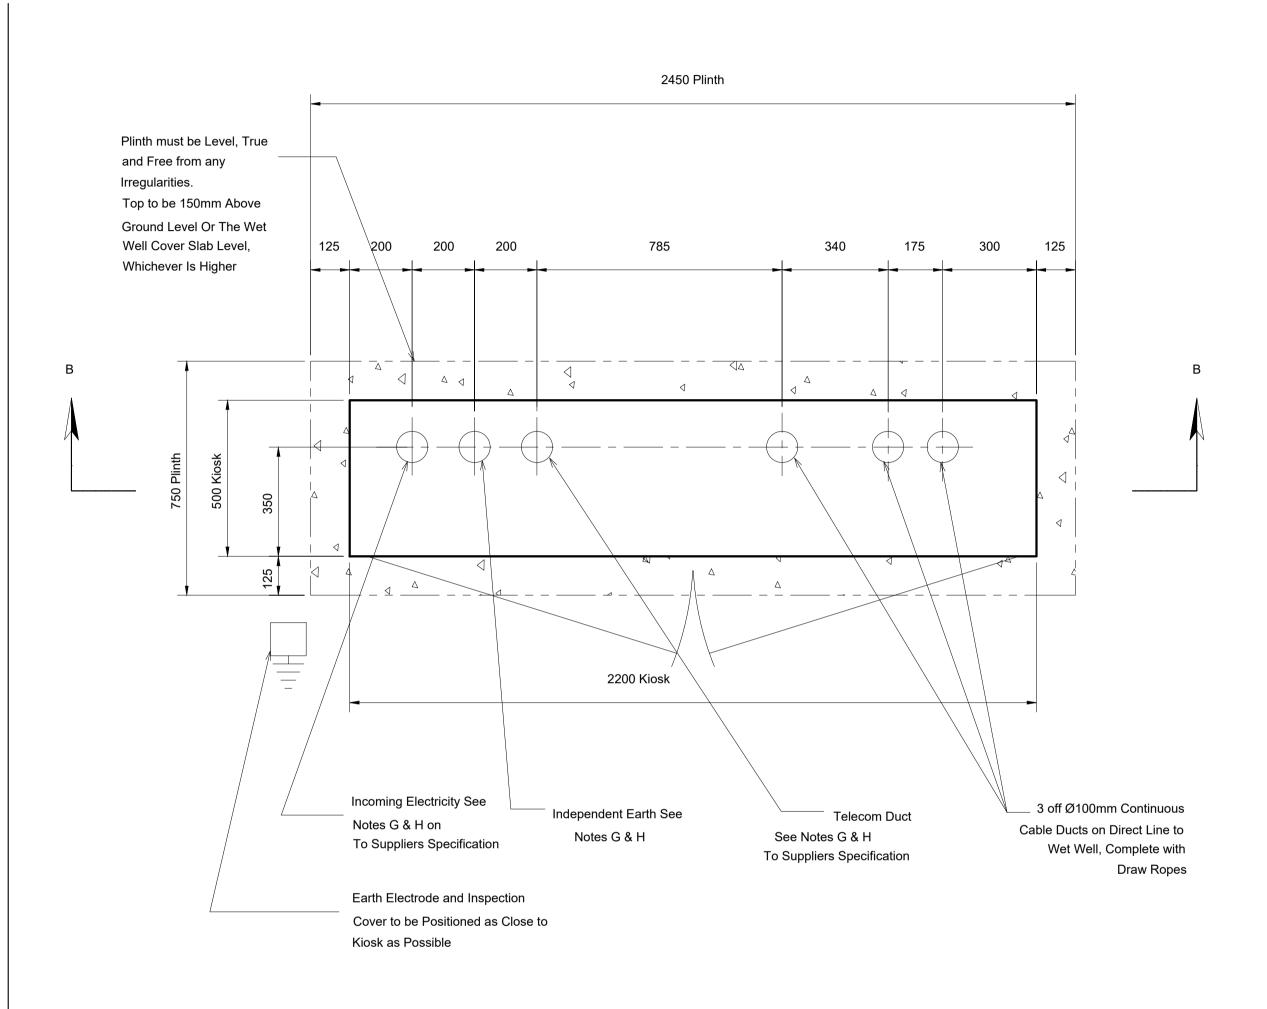

Tolerance on Duct Centre Positions ±10mm

All Ducts To Be Cut Level With Top Of Plinth

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REVISION	DATE	INITIALS	DESCRIPTION			
AMENDMENTS ABOVE						
LEGEND						

The position of the Company's apparatus shown on this plan has been taken from existing mains records and is given without obligation or warranty. The accuracy of information cannot be guaranteed and no liability of any kind whatsoever is accepted by Yorkshire Water Services Ltd. for any error or omission. Any damage to the Company's apparatus as a result of your works may have serious consequences and you will be held responsible for all costs incurred. Prior to commencing major wor the exact location and depth of the Company's apparatus must be determined on site, if necessary by excavating trial holes. Water supply apparatus should always located by hand excavation prior to use of mechanical plant.



Tel: 01274 608008 New Supplies, Service Centre - Water, P.O. Box 52, Bradford, BD3 7YD


SCHEME TITLE: PUMP STATION - KIOSK AND PLINTH DETAILS
GENERAL ARRANGEMENT

SCHEME DETAILS: ----------

DEVELOPER: -----

DESIGNER: WENDY MULLANEY X1DEV No: ---
DATE: 14/01/2021 ORDER No: ---
SCALE: N.T.S ORDER No: ---
GRID REF: ----- FIRE REF: ----
ICE REF: ----- DRAWING No: YWS-DS-SD-WW-004

Kiosk 1350 high Kiosk Complies With Yorkshire Water's CODES FOR ADOPTION

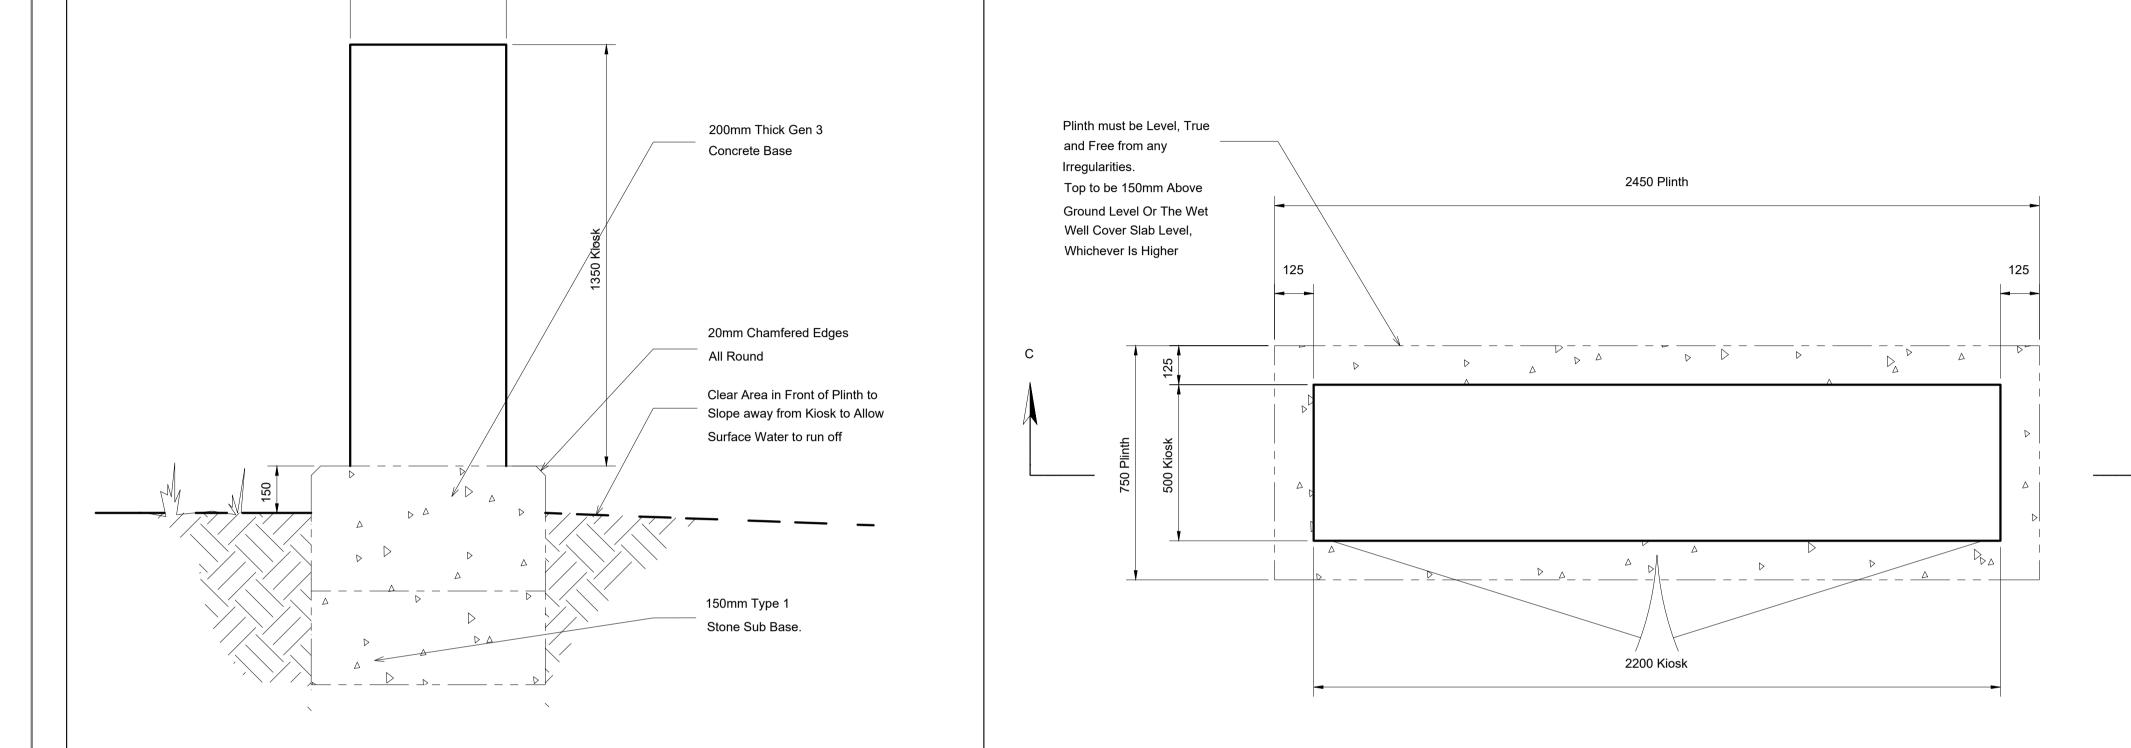

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REVISION DATE INITIALS DESCRIPTION

AMENDMENTS ABOVE

LEGEND

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Tel: 01274 608008 New Supplies, Service Centre - Water, P.O. Box 52, Bradford, BD3 7YD

SCHEME TITLE: PUMP STATION - PLAN VIEW OF KIOSK AND PLINTH
GENERAL ARRANGEMENT

SCHEME DETAILS: ----

DEVELOPER: -----

DEVELOPER:			
DESIGNER:	WENDY MULLANEY	X1DEV No:	
DATE:	14/01/2021	ORDER No:	
SCALE:	N.T.S	ORDER No:	
GRID REF:		FIRE REF:	
ICE REF:		DRAWING No:	YWS-DS-SD-WW-005


KIOSK DOORS FITTED WITH TRIANGULAR KEYED
CAMLOCKS AT THE TOP AND BOTTOM OF EACH
DOOR AND A SECURE HARDENED HASP AND
STAPLE SIZED TO TAKE A YORKSHIRE WATER
SIZED SERVICES PADLOCK.

500 Kiosk

VIEW ON SECTION C - C

Tolerance on Duct Centre Positions ±10mm

All Ducts To Be Cut Level With Top Of Plinth

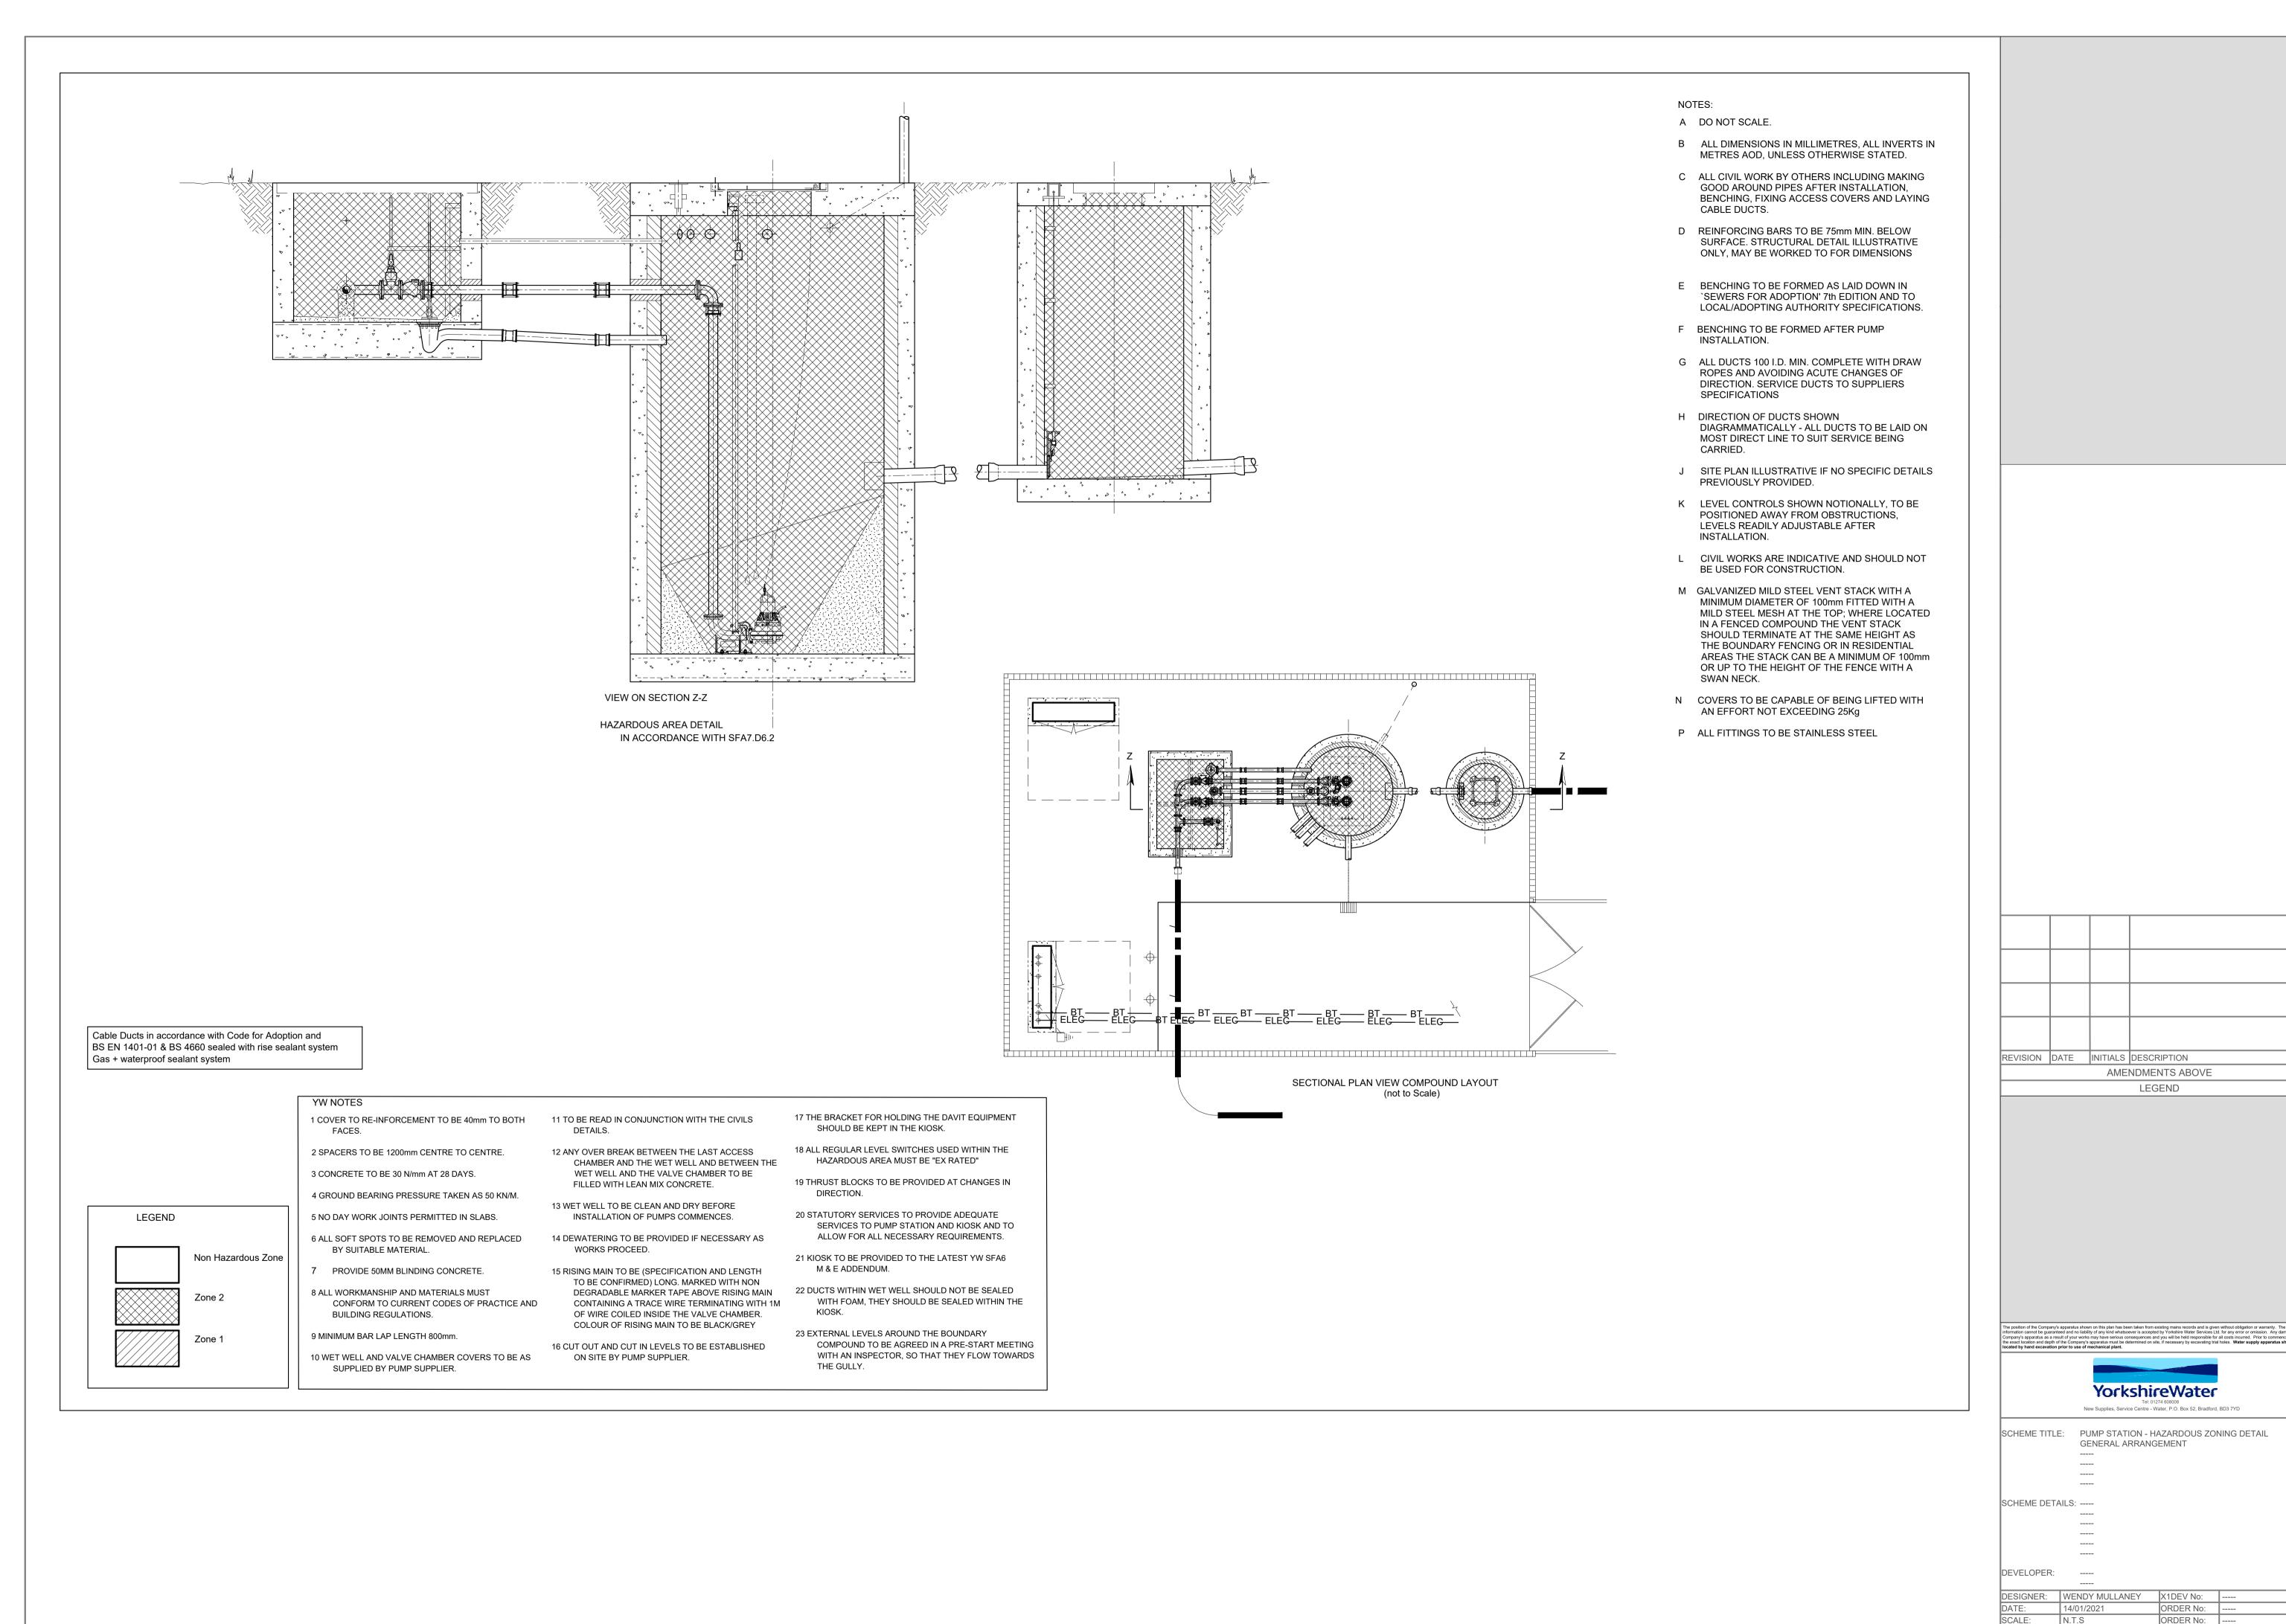


GRID REF: -----

ICE REF: ----

FIRE REF:

DRAWING No: YWS-DS-SD-WW-006

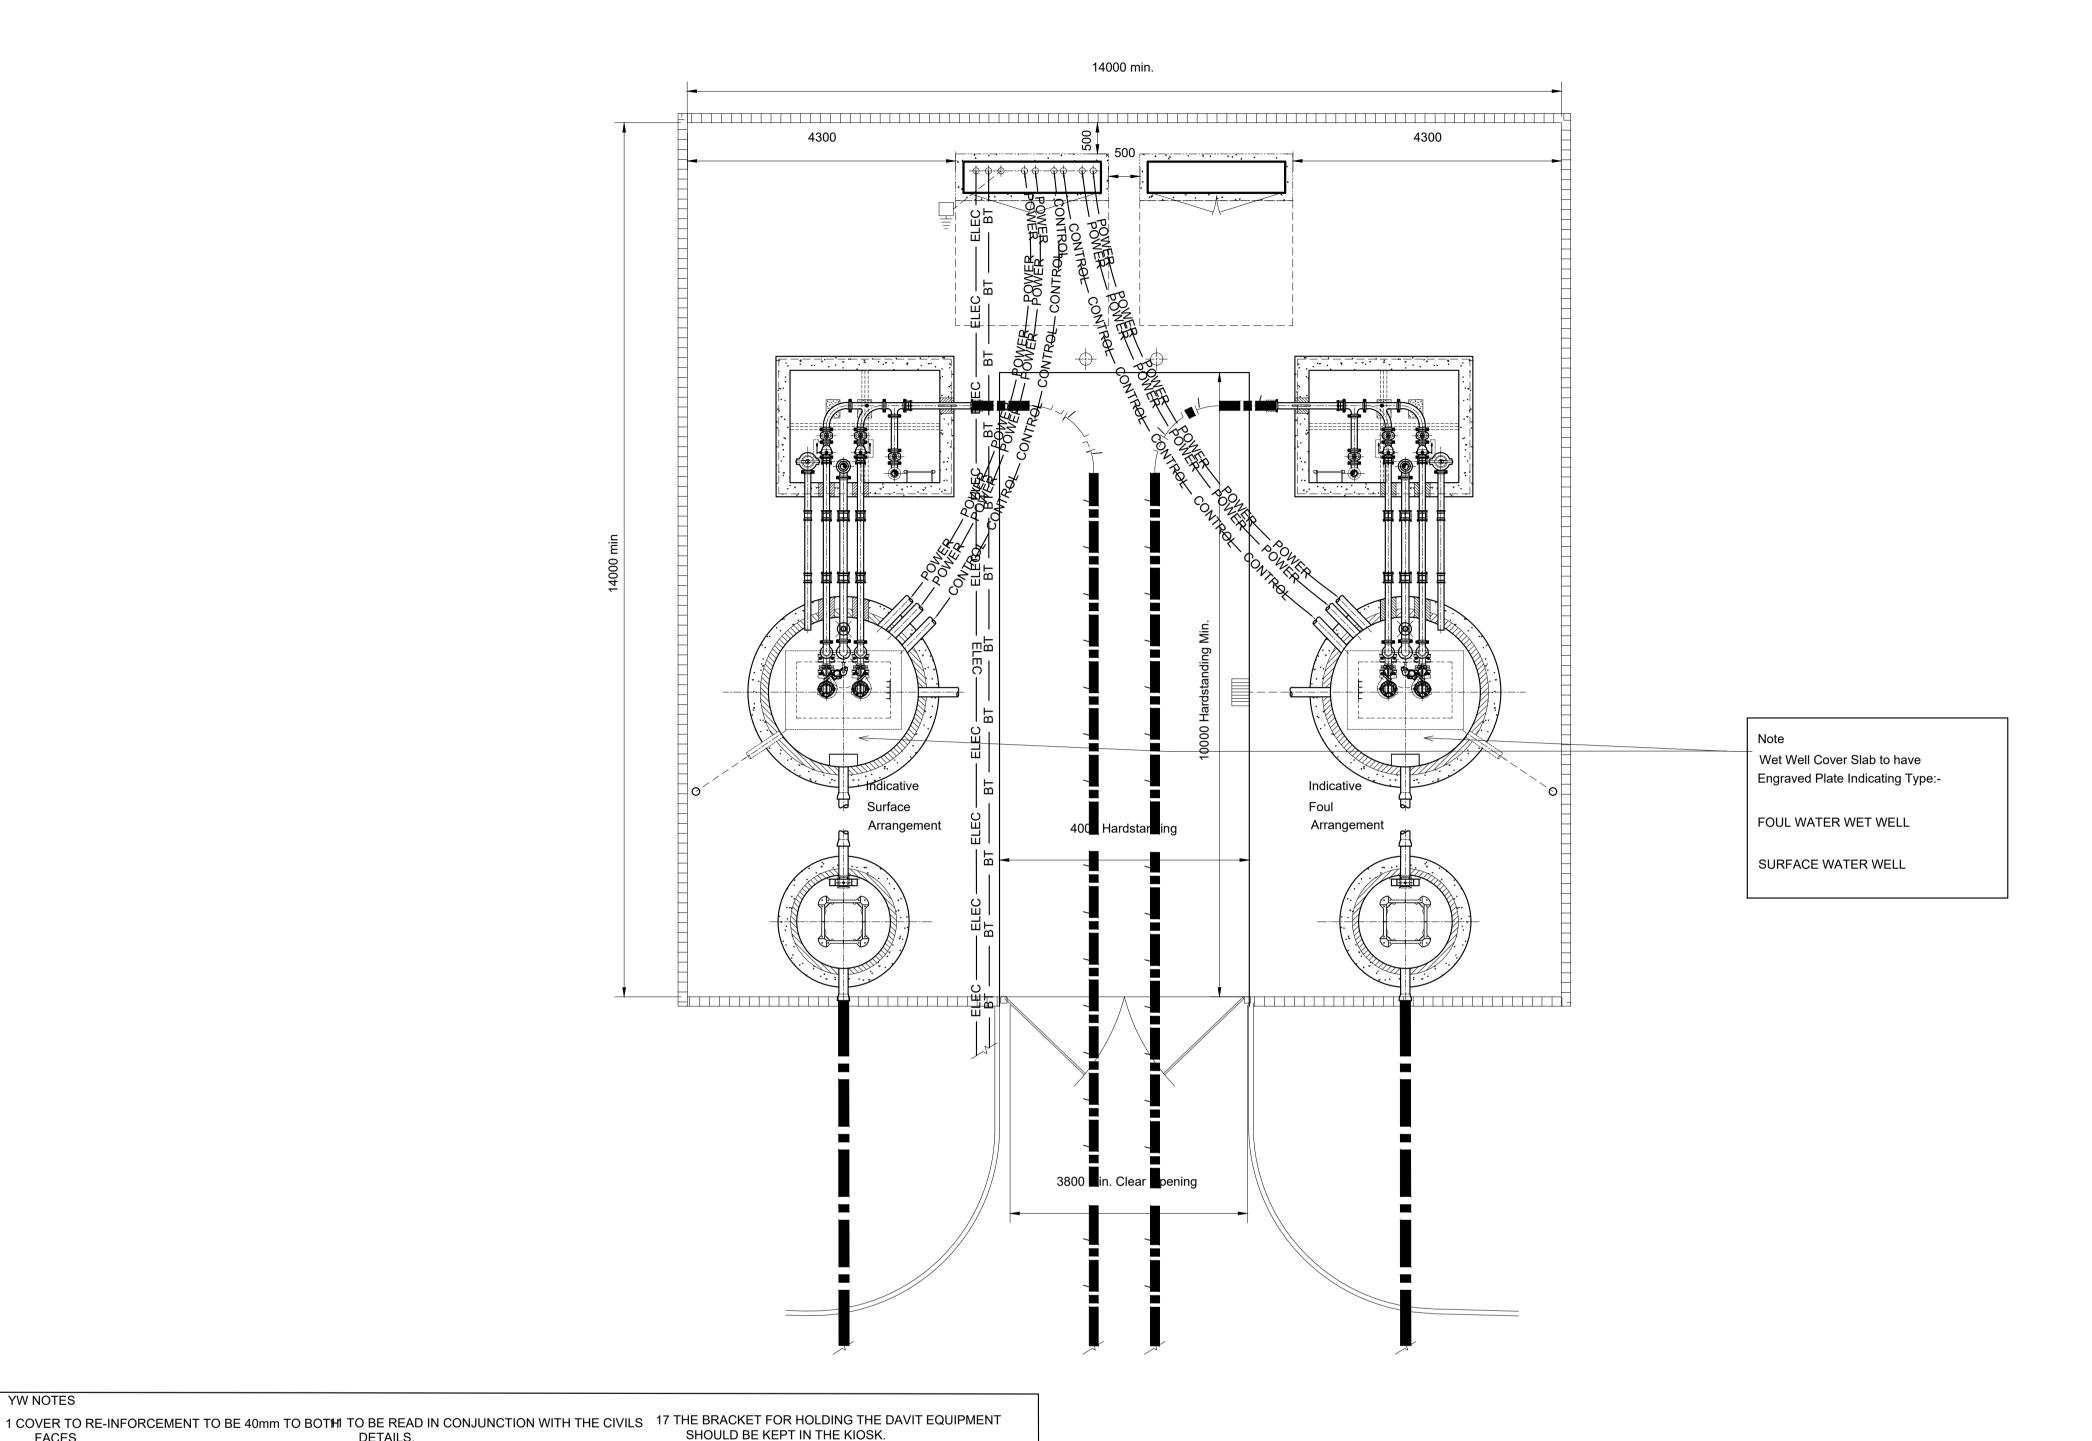

YW NOTES

3 CONCRETE TO BE 30 N/mm AT 28 DAYS.

BY SUITABLE MATERIAL.

BUILDING REGULATIONS.

9 MINIMUM BAR LAP LENGTH 800mm.

SUPPLIED BY PUMP SUPPLIER.

4 GROUND BEARING PRESSURE TAKEN AS 50 KN/M.

5 NO DAY WORK JOINTS PERMITTED IN SLABS.

7 PROVIDE 50MM BLINDING CONCRETE.

8 ALL WORKMANSHIP AND MATERIALS MUST

10 WET WELL AND VALVE CHAMBER COVERS TO BE AS ON SITE BY PUMP SUPPLIER.

DETAILS.

2 SPACERS TO BE 1200mm CENTRE TO CENTRE. 12 ANY OVER BREAK BETWEEN THE LAST ACCESS 18 ALL REGULAR LEVEL SWITCHES USED WITHIN THE

WET WELL AND THE VALVE CHAMBER TO BE

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13 WET WELL TO BE CLEAN AND DRY BEFORE

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INSTALLATION OF PUMPS COMMENCES.

6 ALL SOFT SPOTS TO BE REMOVED AND REPLACED 4 DEWATERING TO BE PROVIDED IF NECESSARY AS ALLOW FOR ALL NECESSARY REQUIREMENTS.

TO BE CONFIRMED) LONG. MARKED WITH NON

COLOUR OF RISING MAIN TO BE BLACK/GREY

CONFORM TO CURRENT CODES OF PRACTICE AND CONTAINING A TRACE WIRE TERMINATING WITH 1M WITH FOAM, THEY SHOULD BE SEALED WITHIN THE OF WIRE COILED INSIDE THE VALVE CHAMBER. KIOSK.

15 RISING MAIN TO BE (SPECIFICATION AND LENGTH M & E ADDENDUM.

CHAMBER AND THE WET WELL AND BETWEEN THE HAZARDOUS AREA MUST BE "EX RATED"

DEGRADABLE MARKER TAPE ABOVE RISING MARY DUCTS WITHIN WET WELL SHOULD NOT BE SEALED

16 CUT OUT AND CUT IN LEVELS TO BE ESTABLISHED COMPOUND TO BE AGREED IN A PRE-START MEETING

19 THRUST BLOCKS TO BE PROVIDED AT CHANGES IN

20 STATUTORY SERVICES TO PROVIDE ADEQUATE

21 KIOSK TO BE PROVIDED TO THE LATEST YW SFA6

23 EXTERNAL LEVELS AROUND THE BOUNDARY

SERVICES TO PUMP STATION AND KIOSK AND TO

WITH AN INSPECTOR, SO THAT THEY FLOW TOWARDS

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REVISION DATE INITIALS DESCRIPTION AMENDMENTS ABOVE

LEGEND




New Supplies, Service Centre - Water, P.O. Box 52, Bradford, BD3 7YD

SCHEME TITLE: PUMP STATION - SITE VIEW (DUAL PUMP) GENERAL ARRANGEMENT

SCHEME DETAILS: -----

DEVELOPER:

DESIGNER: WENDY MULLANEY X1DEV No: ORDER No: N.T.S SCALE: ORDER No: GRID REF: -----FIRE REF: DRAWING No: YWS-DS-SD-WW-007 ICE REF: ----

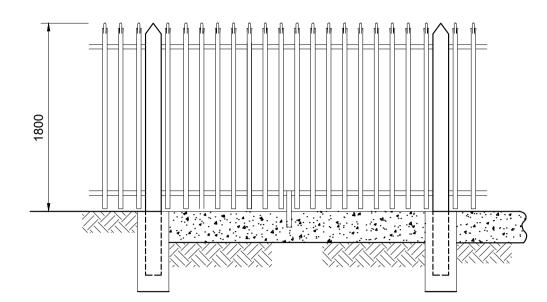

1800mm Palisade Fencing - Elevation

1800mm Brick Wall - Elevation

1 COVER TO RE-INFORCEMENT TO BE 40mm TO BOTH 11 TO BE READ IN CONJUNCTION WITH THE CIVILS

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CONTAINING A TRACE WIRE TERMINATING WITH 1M OF WIRE COILED INSIDE THE VALVE CHAMBER.

CHAMBER AND THE WET WELL AND BETWEEN THE

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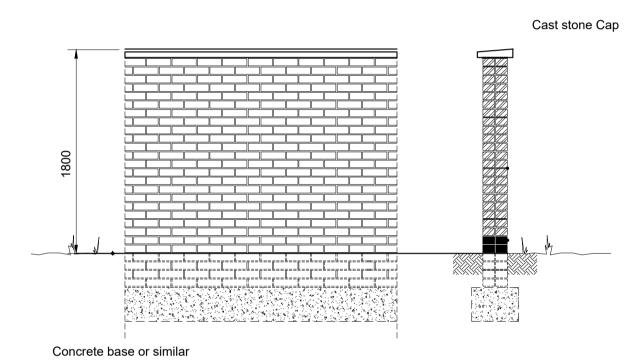
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BY SUITABLE MATERIAL.

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SUPPLIED BY PUMP SUPPLIER.



1800mm Brick Wall - Section

17 THE BRACKET FOR HOLDING THE DAVIT EQUIPMENT

18 ALL REGULAR LEVEL SWITCHES USED WITHIN THE

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COMPOUND TO BE AGREED IN A PRE-START MEETING

WITH AN INSPECTOR, SO THAT THEY FLOW TOWARDS

SERVICES TO PUMP STATION AND KIOSK AND TO ALLOW FOR ALL NECESSARY REQUIREMENTS.

HAZARDOUS AREA MUST BE "EX RATED"

SHOULD BE KEPT IN THE KIOSK.

DIRECTION.

M & E ADDENDUM.

KIOSK.

Foundation sizes to be calculated to suit weight of gates and ground

conditions

Section

1200mm Bow Top Fencing - Elevation

Cast stone Cap Concrete base or similar

1200mm Brick Wall - Elevation

1800mm Brick Wall

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REVISION DATE INITIALS DESCRIPTION AMENDMENTS ABOVE LEGEND



New Supplies, Service Centre - Water, P.O. Box 52, Bradford, BD3 7YD

SCHEME TITLE: PUMP STATION - BOUNDARY TREATMENT OPERATIONS GENERAL ARRANGEMENT SCHEME DETAILS: -----

DESIGNER: WENDY MULLANEY X1DEV No: ORDER No: N.T.S SCALE: ORDER No: GRID REF: -----FIRE REF:

DRAWING No: YWS-DS-SD-WW-008

ICE REF: ----

DEVELOPER:

For more information contact:

Sewer Adoption, Diversion and Requisition Team Developer Services

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